



(NO CHANGE)

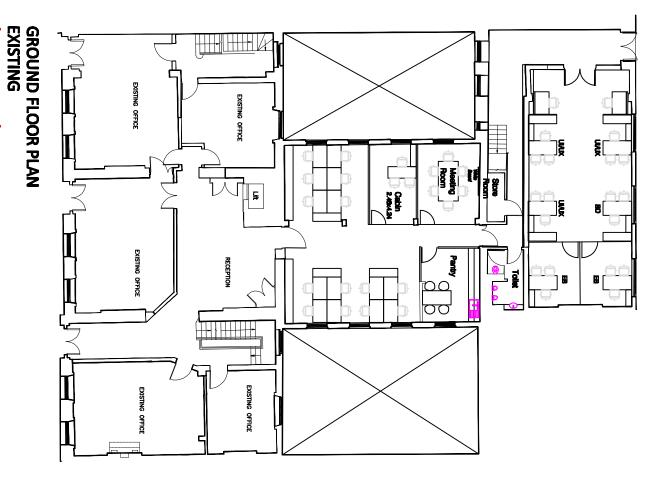


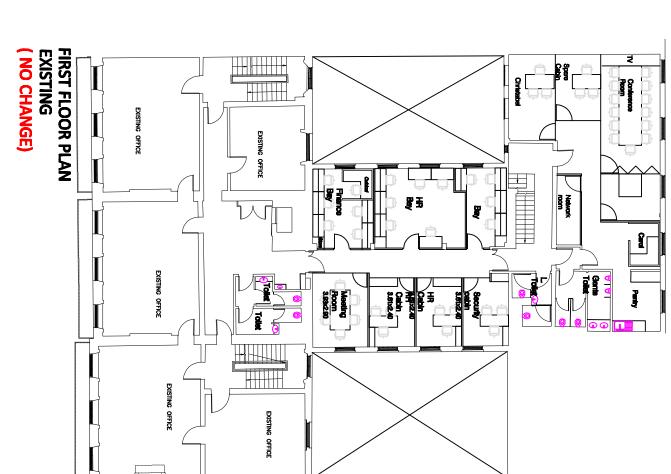

LTD



	STING LEVEL TO		
DRAWN: J.V	DRAWING NUMBER: GLAO1L	SCALE: 1:200	DATE: 10.01.2019
CHECK: R.K	JLA-O1L		

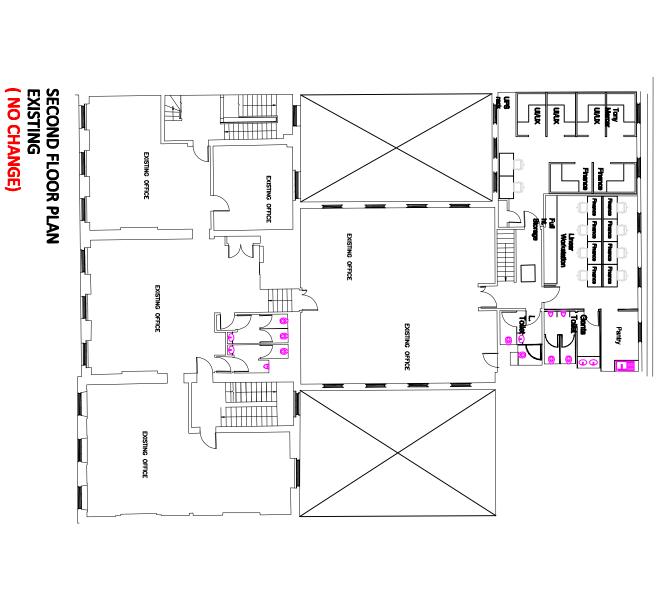




CONSULTANTS

LTD


as an oriented without the length of the bearing. It is the responsibility of the the required length of any structural member on ells.


semed to be the reaponability of the client unions the Archhoot is reporate agreement to undertake such matters. And to well for full planning permission and full building regulations to be

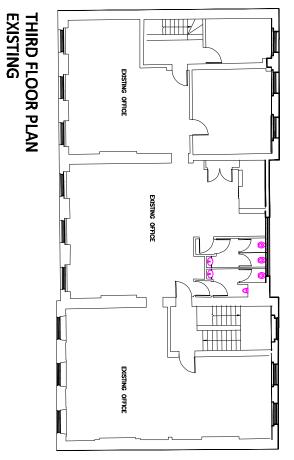


PROPOSAL: CONVERSION OF TH OFFICE AT THIRD FL STAFF ACCOMODA:		

A 1.23 DORSE I SQUARE	SITE ADDRESS: 21:23 DORSET SQUARE		PROPOSAL: CONVERSION OF THE EXISTING OFFICE AT THIRD FLOOR LEVEL TO STAFF ACCOMODATION		
REV:	DRAWN: J.V	DRAWING NUMBER: GLA-02L	SCALE: 1:200	DATE: 10.01.2019	
	CHECK: R.K	GLA-O2L			

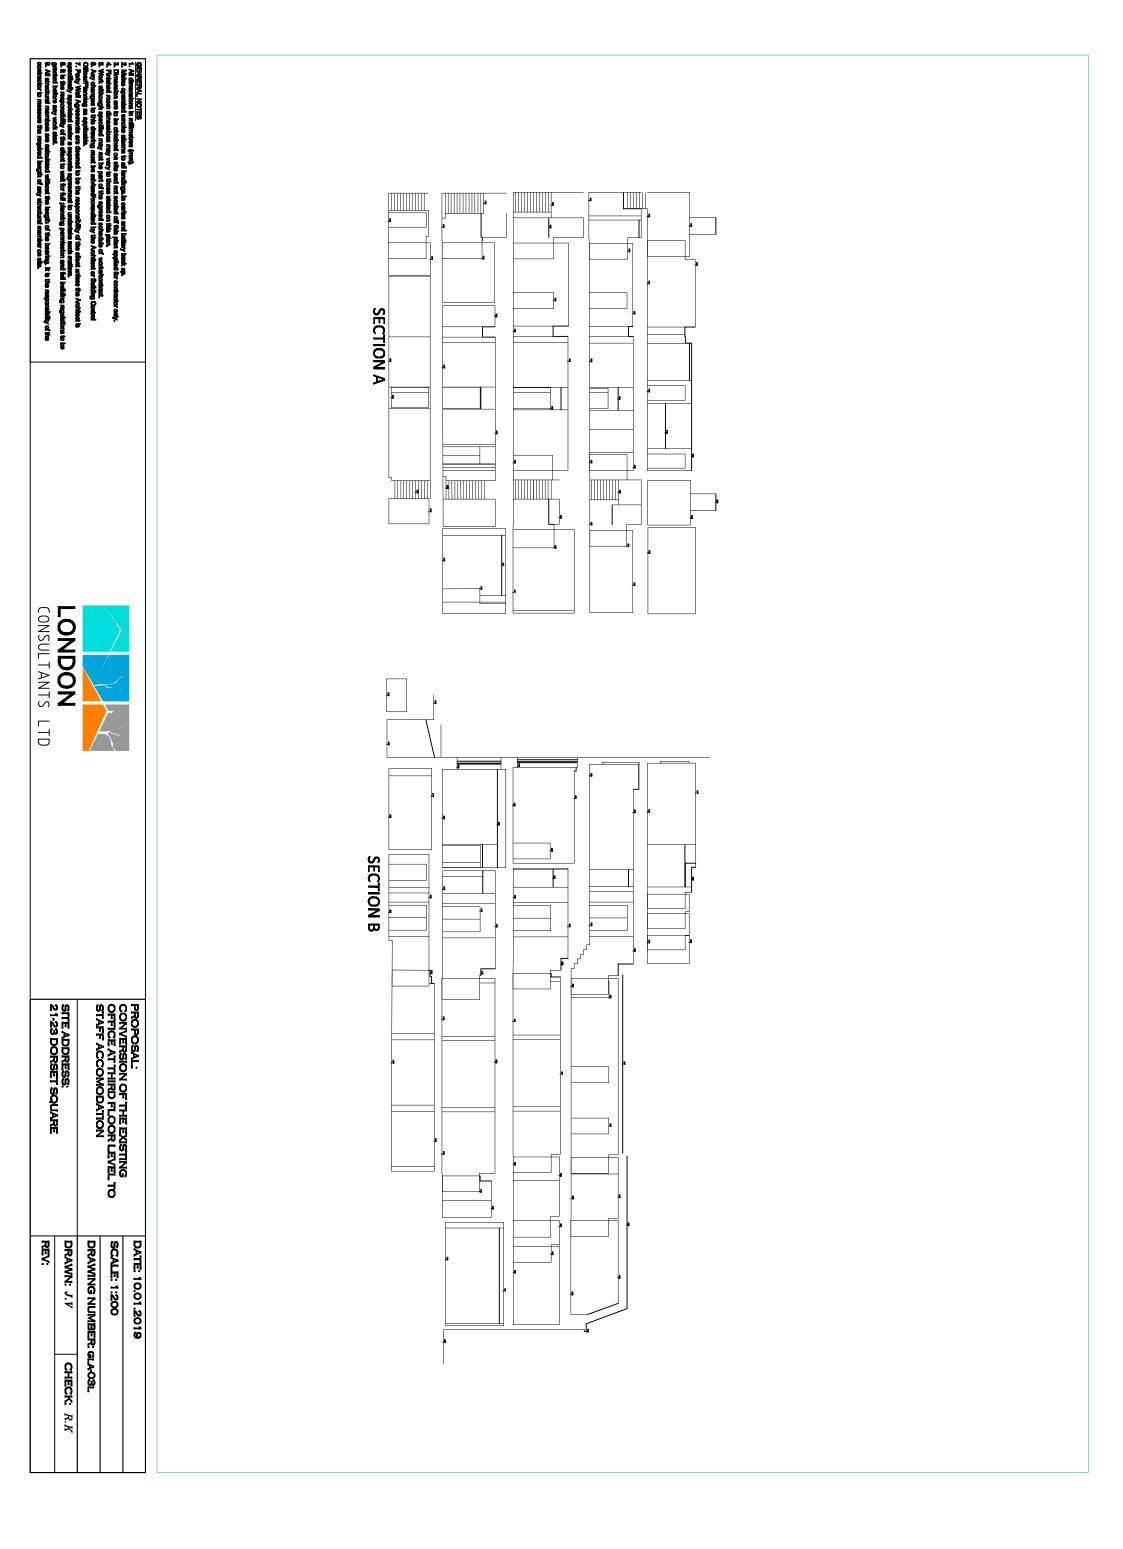

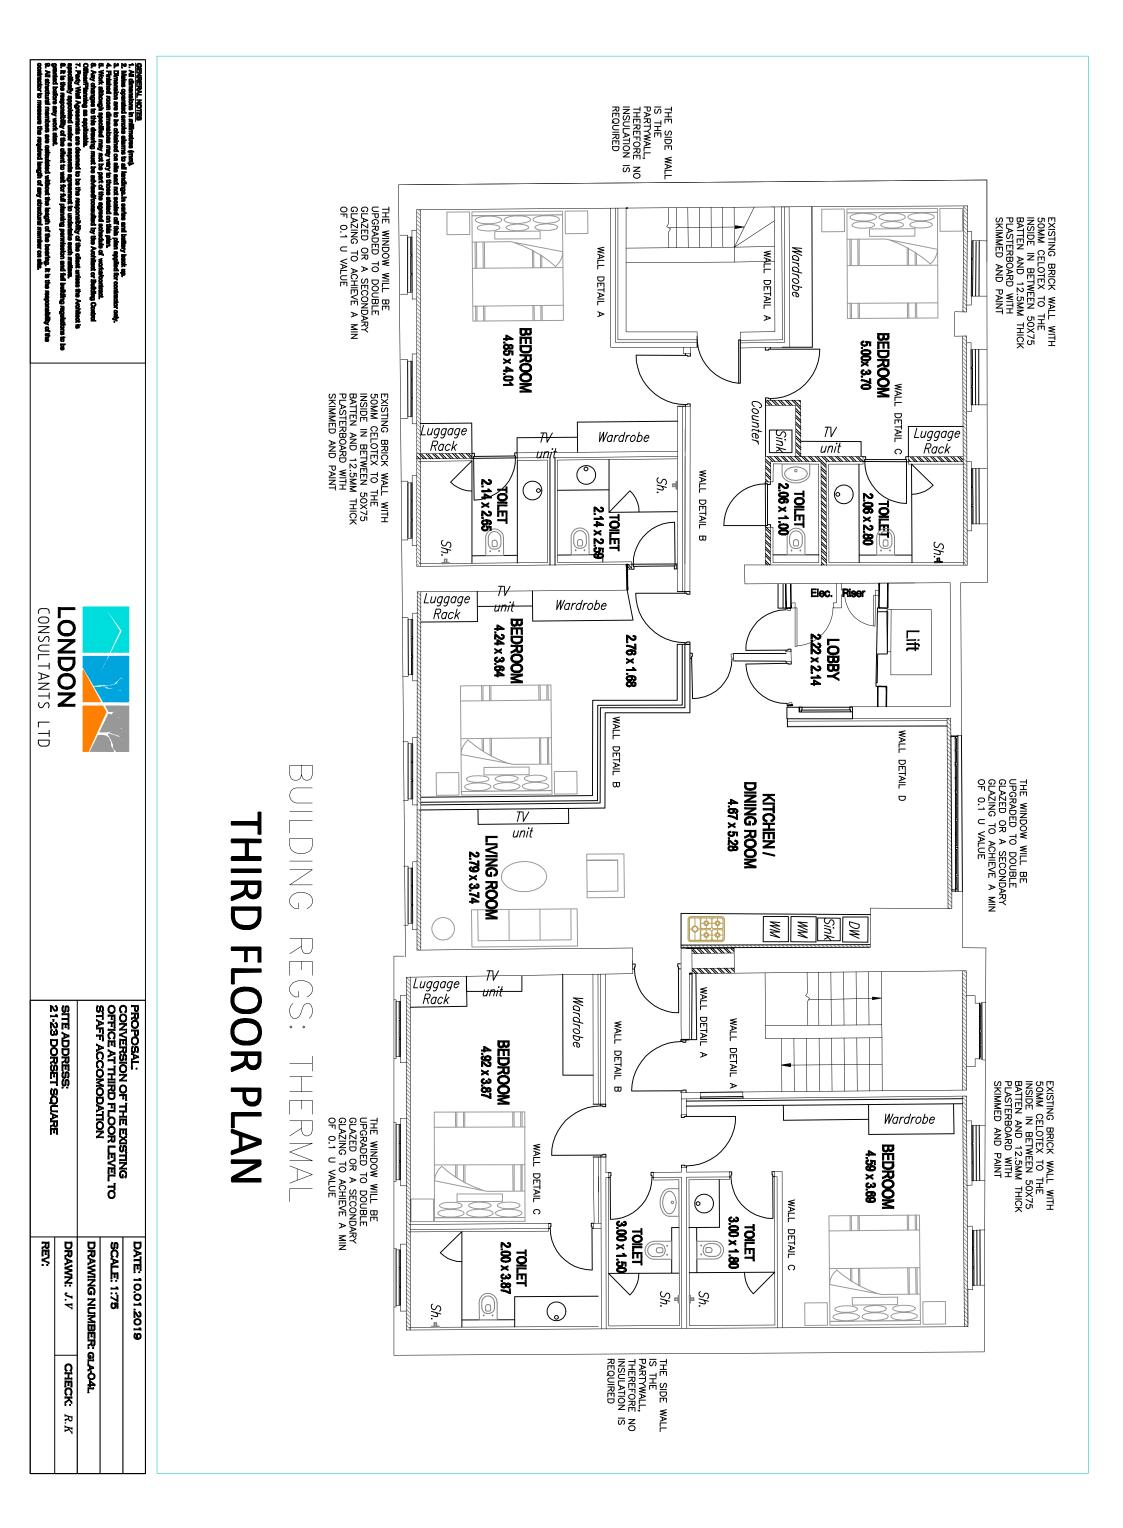

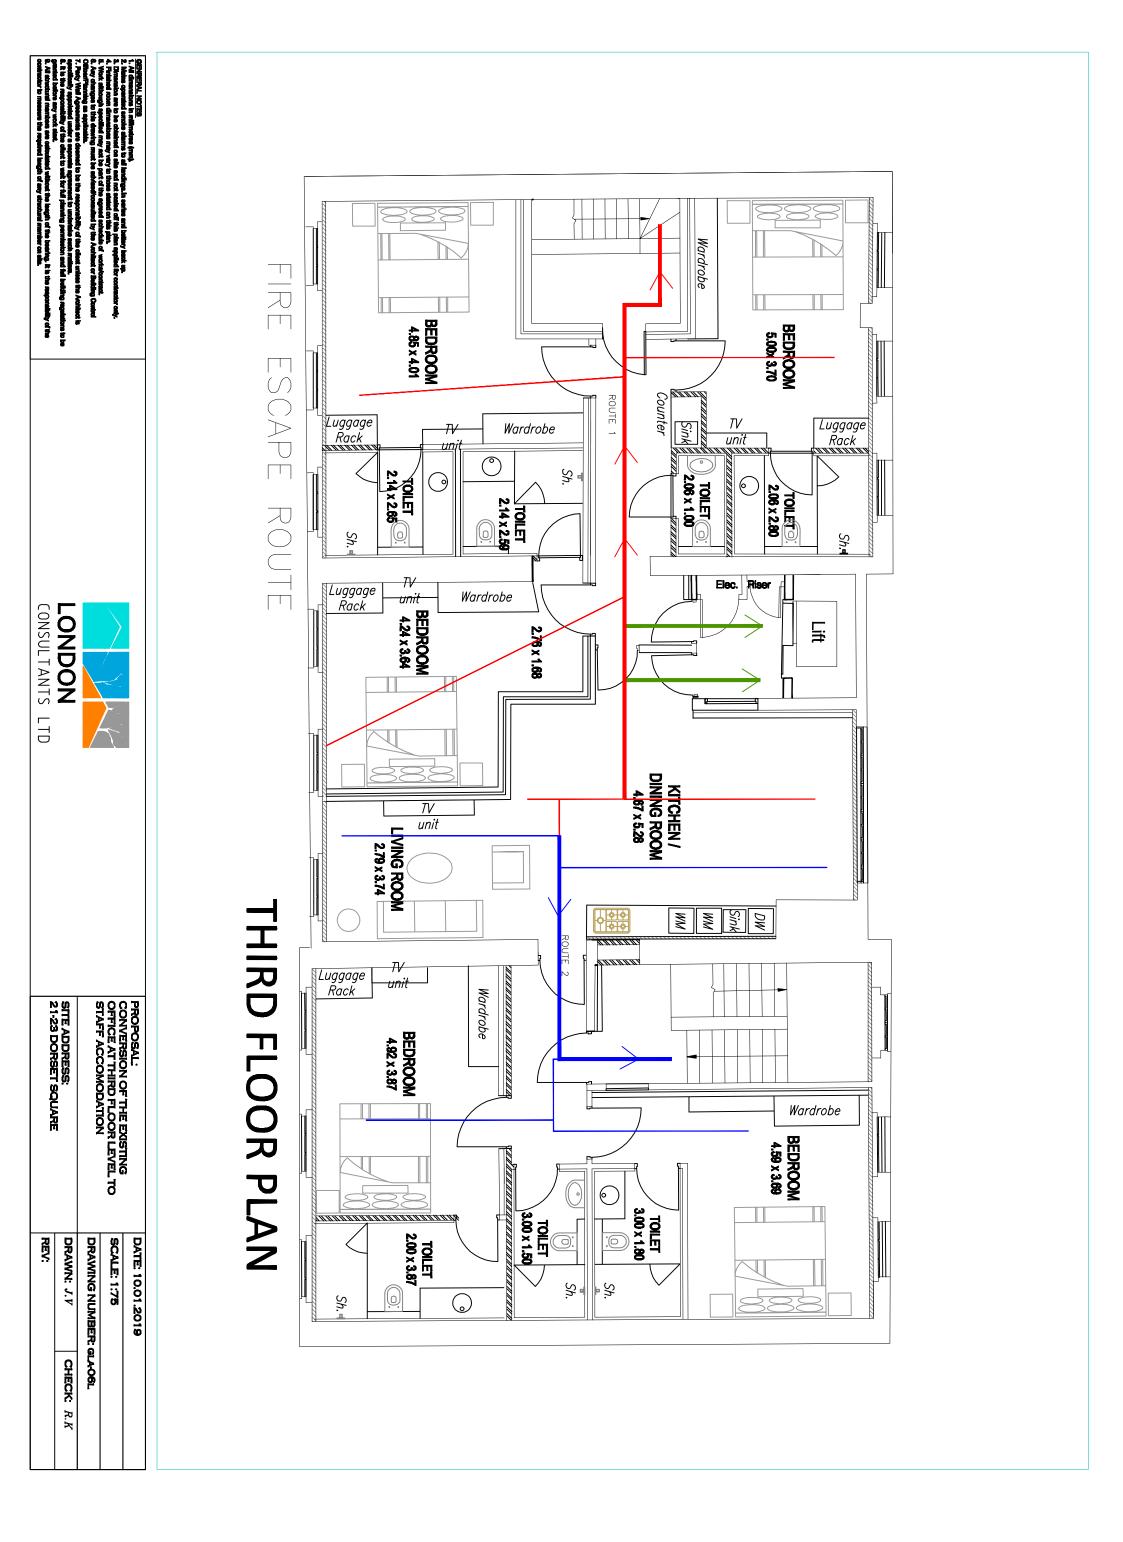

A COMMISSIONING NOTICE FOR THE FIXED BUILDING SERVICES (HEATING AND HOT WATER) WILL BE DEMOSITED WITH THE COUNCIL UPON COMPLETION OF THE WORK. THE INSULATED DRY LINING EXTENDS TO ALL PARTY AND EXTERNAL WALLS.

THE DESIGN DETAILS AND BUILDING TECHNIQUES HAVE BEEN SPECIFIED IN ACCORDANCE WITH THE GUIDANCE GIVEN IN "LIMITING THERMAL RENDGING AND AIR LEAKAGE, ROBUST CONSTRUCTION DETILS FOR DWELINGS AND SIMILAR BUILDINGS 2002" A REPORT WILL BE PROVIDED TO THE COUNSIL IN RELATION TO THE WORK CARRIED OUT


EMERGENCY LIGHTING TO COMMON AREAS. SHOULD BE INSTALLED ACCORDING TO BS 5266:1

SMOKE DETECTOR IN CORRIDOR, ON LANDINGS AND HEAT ALARM IN KITCHEN IN ACCORDANCE WITH THE RECOMMENDATIONS OF BS 5839-6.

ALL THE SMOKE DETECTORS SHOULD BE INTERLINKED AND MAINS OPERATED WITH BATTERY BACKUP. THE SMOKE DETECTORS MUST BE ACCESSIBLE TO ALLOW FOR TESTING AND CLEANING. THE SMOKE ALARM SHOULD BE WITHIN 7.5M OF THE DOOR TO EVERY HABITABLE ROOMS AND ARE CEILING MOUNTED. IT SHOULD BE LOCATED BETWEEN 25-600MM BELOW THE CEILING AND 300MM AWAY FROM ANY LIGHT.

• (2) C/P ∄ CALL POINT SMOKE ALARM HEAT ALARM FIRE ALARM FIRE EXIT SIGN EMERGENCY LIGHTING FIRE EXTINGUISHER 30 MINS FIRE DOOR FIRE CONTROL UNIT

SELF CLOSURES THIRD FLOOR PLAN

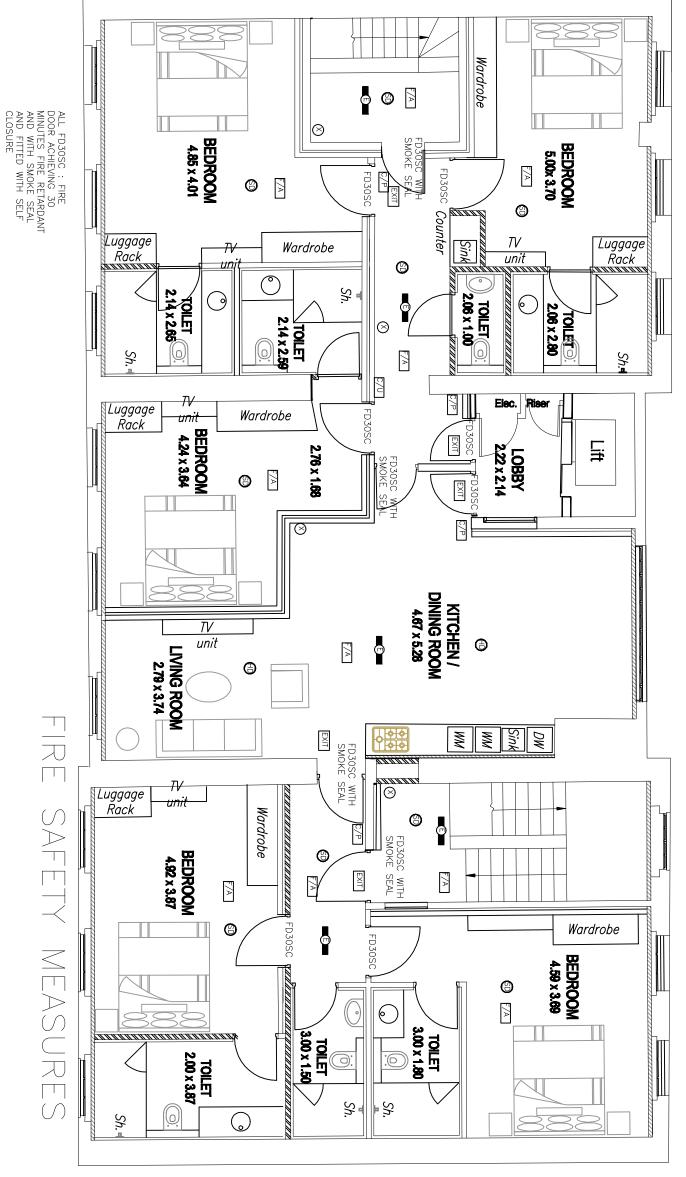

beared to be the reagonability of the offest unless the Archibect is repeate agreement to undertake each matter.


thent to work for full planning permission and fall belicing argulations to be erhe and ballery back up.
Ind off this plan applied by continuour only.
Ind of this plan applied by continuour only.
Ind on this plan.
peed achieche of works/tontext.
peed achieche of works/tontext.
peud by the Architect or Building Control


es are oriented without the length of the bearing. It is the responsibility of the the required length of any structural member on ella.



PROPOSAL:
CONVERSION OF THE EXISTING
OFFICE AT THIRD FLOOR LEVEL
STAFF ACCOMODATION SITE ADDRESS: 21-23 DORSET SQUARE <u>d</u>

DATE: 10.01.2019 DRAWN: J.V DRAWING NUMBER: GLA-05L SCALE: 1:75 CHECK: R.K

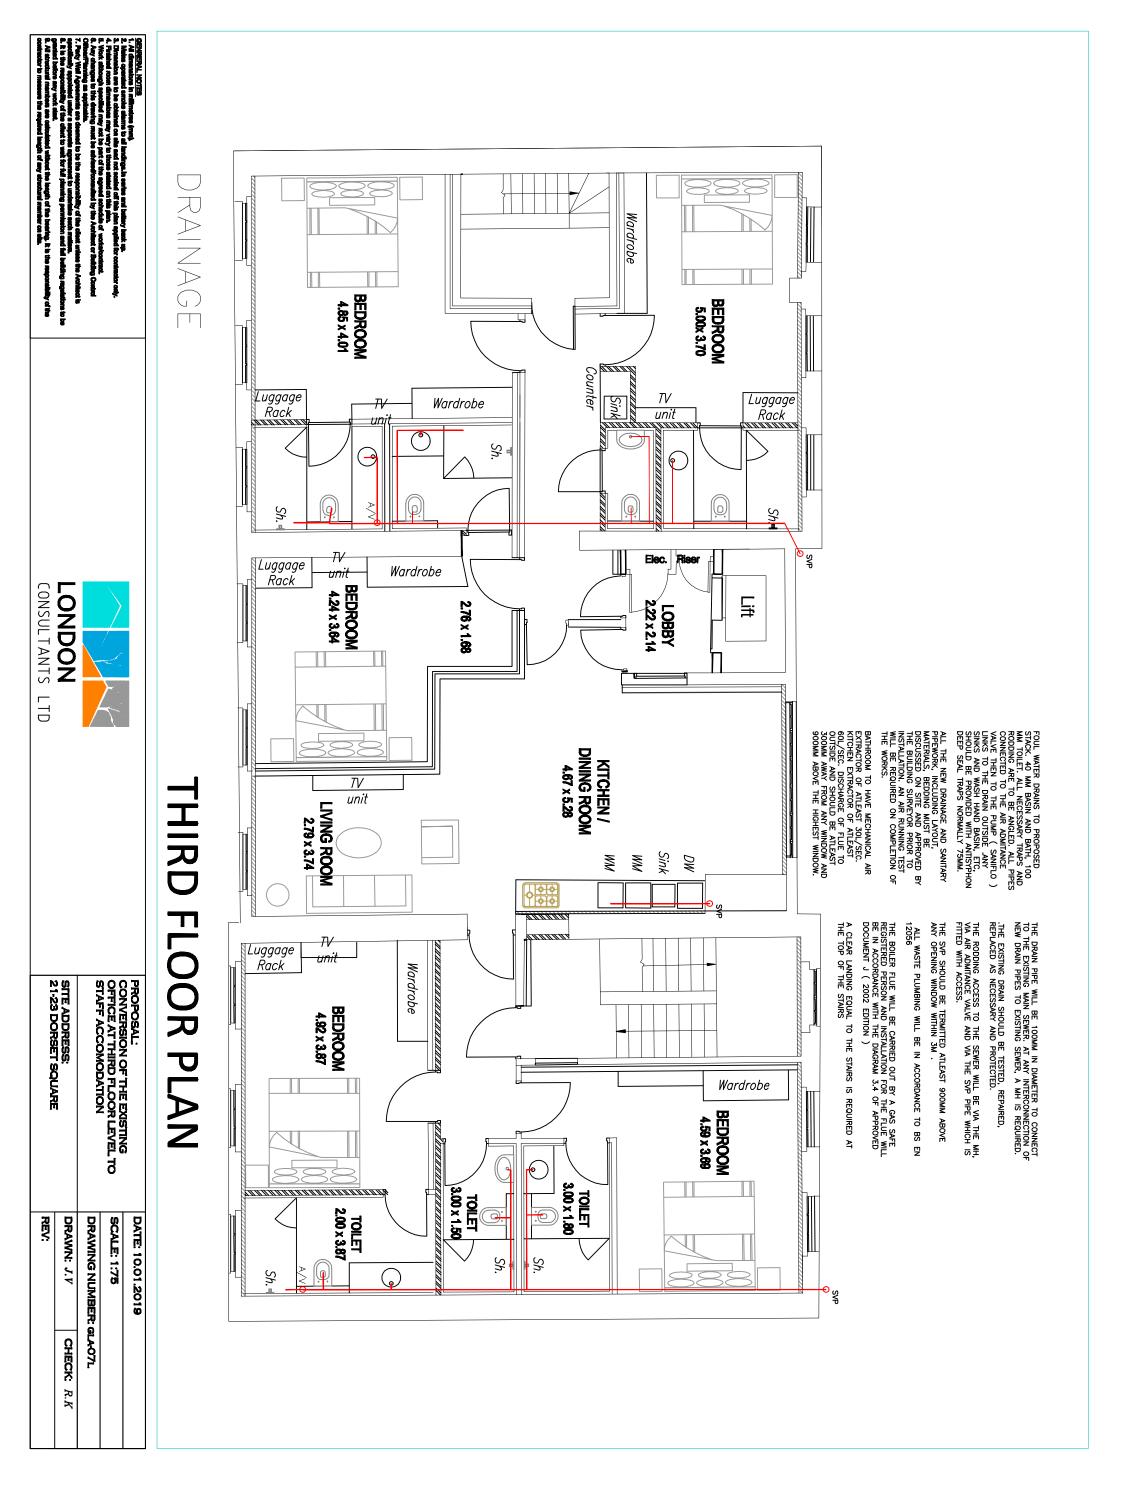

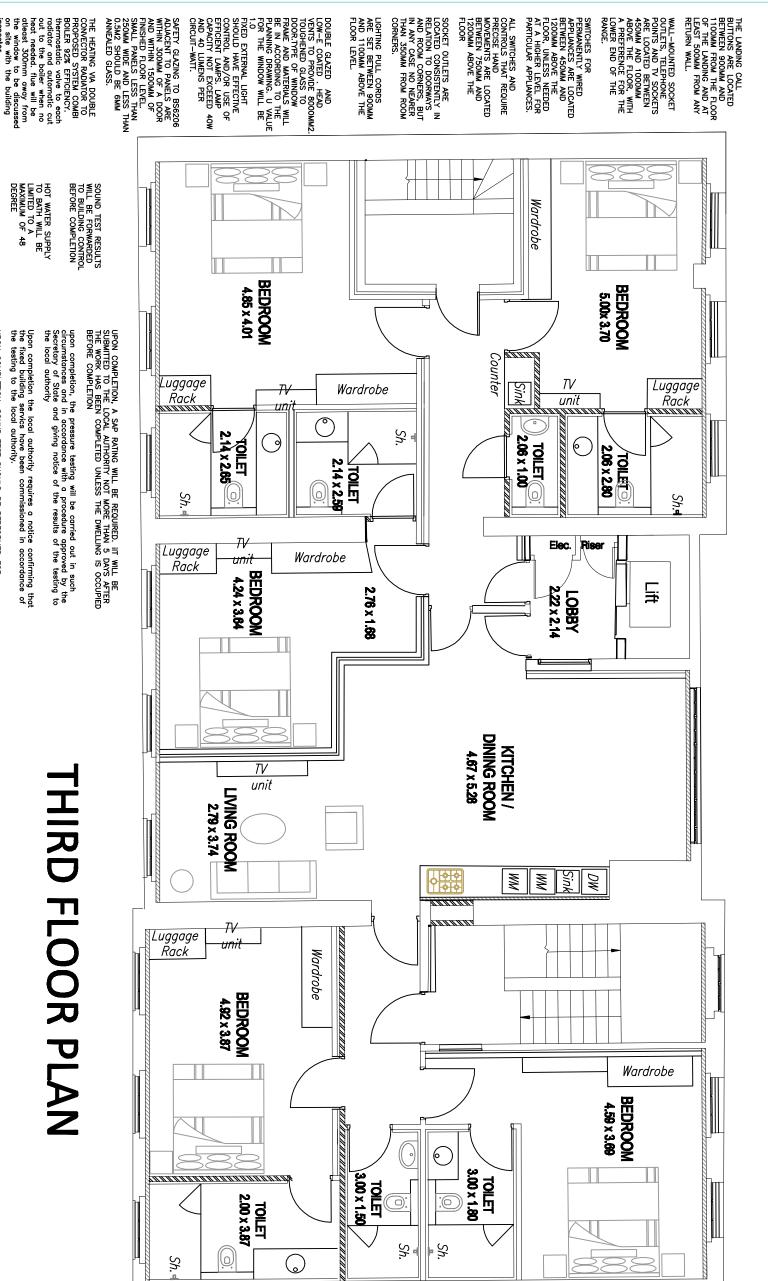

beared to be the reagonability of the offest unless the Archibect is repeate agreement to undertake each matter.

thent to work for full planning permission and fall belicing argulations to be neths and beliesy back up.

Ind off this pinn applied for contractor only.

Ind on this pinn.

greed achicide of vortabonizent.

multed by the Austriact or Beiding Control

multed by the Austriact or Beiding Control

HOT WATER SUPPLY
TO BATH WILL BE
LIMITED TO A
MAXIMUM OF 48
DEGREE

upon completion, the pressure testing will be carried out in such circumstances and in accordance with a procedure approved by the Secretary of State and giving notice of the results of the testing to the local authority

HIRD FLOOR PLAN

Upon completion the local authority requires a notice confirming that the fixed building servics have been commissioned in accordance of the testing to the local authority.

JPON COMPLETION, SOUND TEST SHOULD BE PERFORMED FOR SEPERATING WALLS AND FLOORS FOR ALL THE FLOORS.

recurred without the length of the bearing. It is the responsibility of the fixed length of any structural member on else.



PROPOSAL:
CONVERSION OF THE EXISTING
OFFICE AT THIRD FLOOR LEVEL
STAFF ACCOMODATION SITE ADDRESS: 21-23 DORSET SQUARE ಠ REY:

the hot water supply temperature to a both should be limited to a maximum of 48 degrees celcius to use of an in-line blending valve or other appropriate temperature control device, with a maximum temperature stop and a suitable arrangement of pipework.

ALL ENTRANCES DOORS WILL HAVE SMOKE SEALS AND SELF CLOSURE AND WILL BE FIRE RETARDANT OF ATLEAST 30 MINUTES

THE EXISTING CHIMNEY FLUES ARE SEALED PROPERLY WITH BRICKS TO ENSURE SOUND IS NOT TRANSFERRED VIA FLUES

WINDOWLESS BATHROOM SHOULD HAVE AN EXTRACTOR WHICH HAS ATLEAST 15 MINUTES OVERRUN

BACKGROUND VENTILATION OF ATLEAST 5000 MM2 IS PROVIDED AT THE TOP OF THE WINDOW AS TRICKLE VENT TO NEW HABITABLE ROOMS.
TRICKLE VENTS SHOULD BE LOCATED AT MINIMUM 1700MM FROM THE FLOOR LEVEL.

BACKGROUND VENT OF ATLEAST 2500 MM2 SHOULD BE PROVIDED TO BATHROOM, UTILITY WHICH CONTAINS WINDOW. VIA TRICKLE VENT A MECHANICAL VENTILATION
COMMISSIONING CERTIFICATE
WILL BE SUBMITTED TO THE
COUNCIL NO LONGER THAN 5
DAYS AFTER COMPLETION

THE WATER EFFICIENCY CALCULATOR WILL BE CARRIED OUT AND SUBMITTED TO THE COUNCIL NOT LATER THAN 5 DAYS AFTER THE COMPLETION


THE WHOLESOME WATER IS COMING FROM THE EXISTING WATER SUPPLY FROM THE MAINS.


PROVISION MUST BE MADE BY THE INSTALLATION OF FITTINGS AND FIXED APPLIANCES THAT USE WATER EFFICIENTLY FOR PREVENTION OF WATER E.G. WASHING MACHINE, DISH WASHER FITTED WITH CONTROL USE OF WATER, THE WC FLUSH SYSTEM SHOULD HAVE A DUAL PUSH BUTTON: ONE FOR HALF TANK FLUSH AND ONE FOR FULL TANK FLUSH.


HOT WATER SUPPLY FROM THE COMBI BOILER. ANY STORAGE VESSEL WILL HAVE 2 INDEPENDENT SAFETY DEVICES SUCH AS THOSE THAT RELEASE PRESSURE AND SO PREVENT THE TEMPERATURE OF THE STORED WATER AT ANY TIME EXCEEDING 100 DEGREES CELCIUS IN ADDITION TO ANY THERMOSTAT.

THE HOT WATER SYSTEM HAS PIPEWORK THAT INCORPORATES A PROVISION FOR THE DISCHARGE OF HOT WATER FROM SAFELY DEVICES TO BE VISIBLE AT SOME POINT AND SAFELY CONVEYS IT TO AN APPROPRIATE PLACE OPEN TO THE ATMOSPHERE WHERE IT WILL CAUSE NO DANGER TO PERSONS IN OR ABOUT THE BUILDING. FITTED WITH SAFETY DEVICES.

DRAWN: J.V	DRAWING NUMBER: GLA-OBL	SCALE: 1:75	DATE: 10.01.2019	
CHECK: R.K	SLA-OBL			

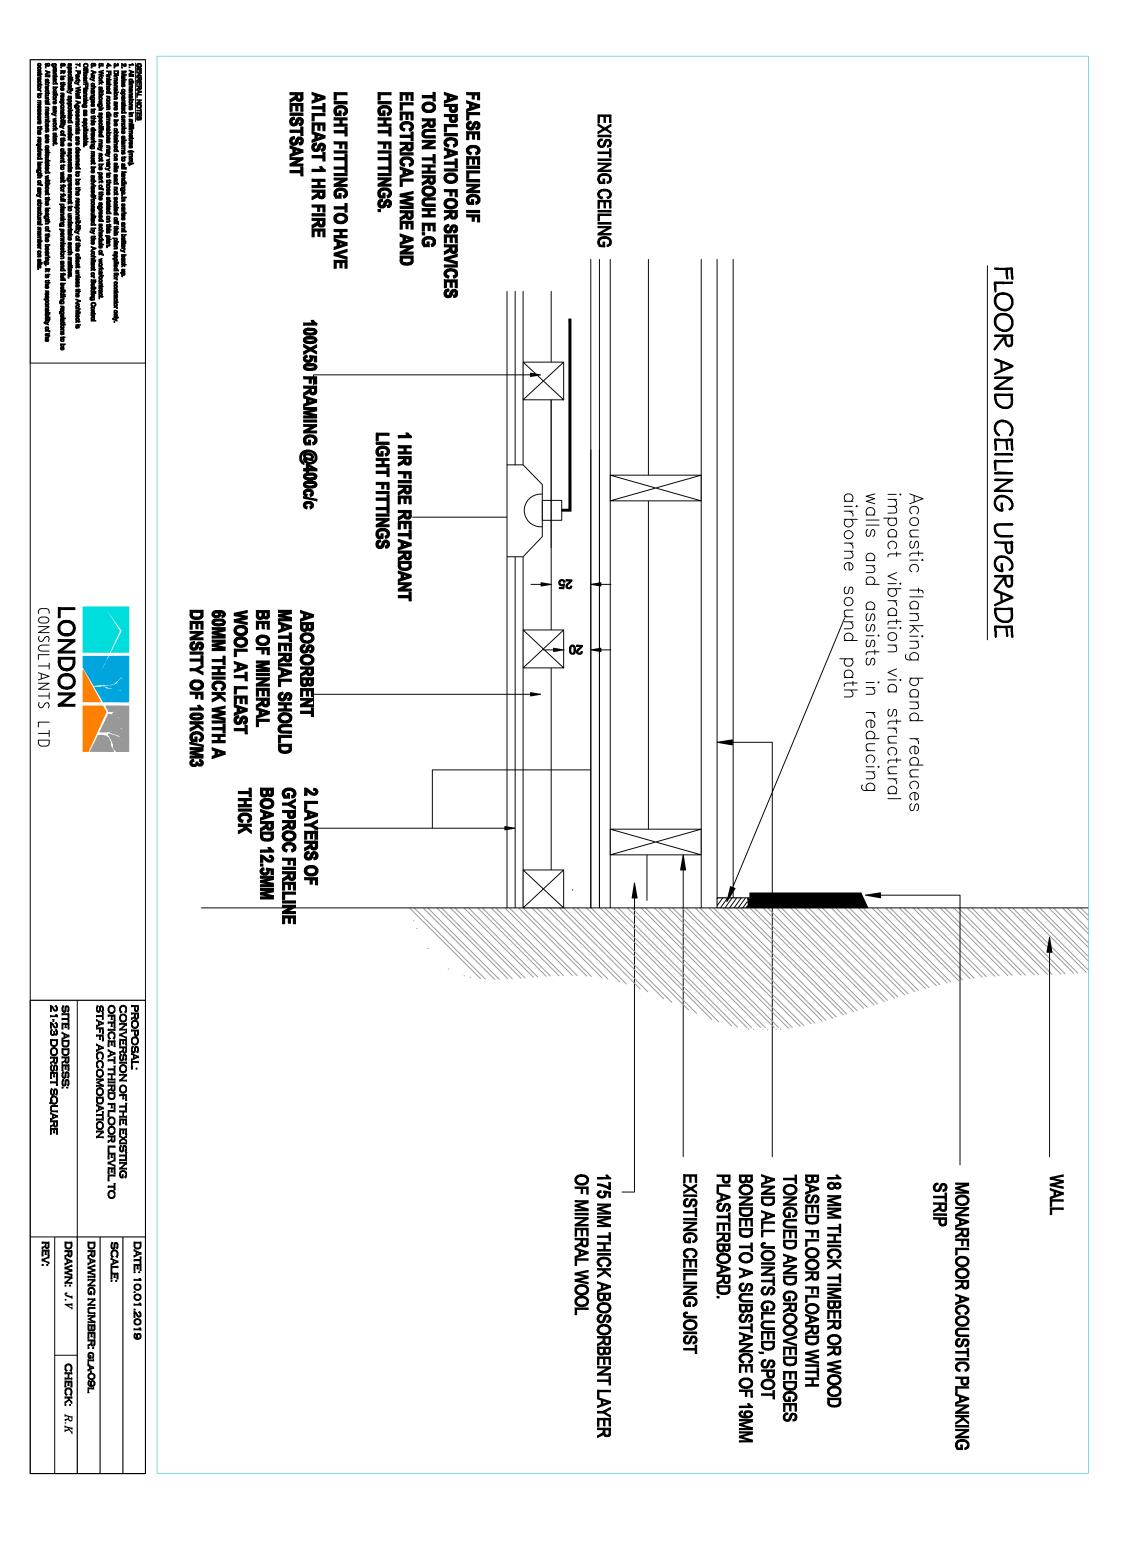

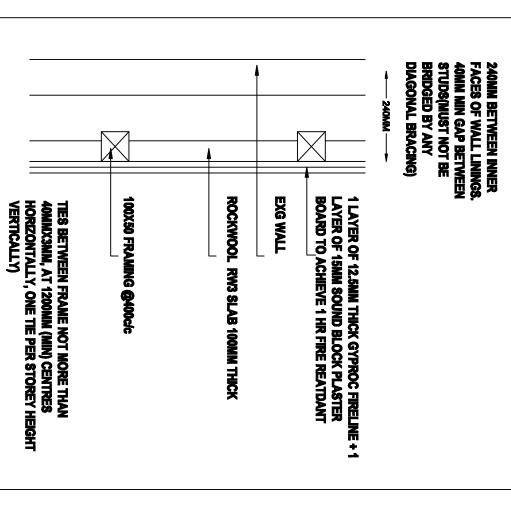

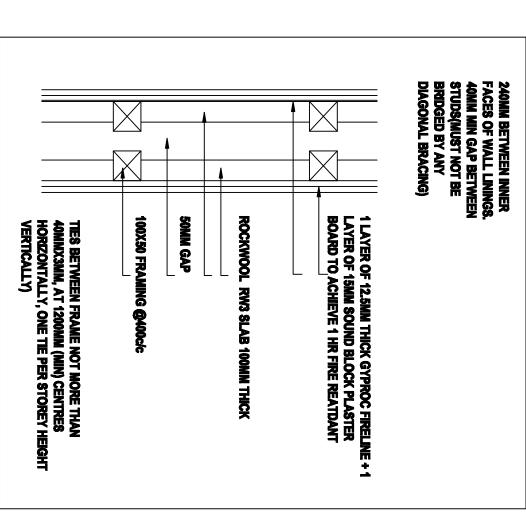

1X12.5MM HICK GYPROC FIRE BOARD

APR1200 IN CAVITY OR DRYTHERM 32.

400C/C WITH

100MM ISOVER

50X100

STUD

0



WALL

TREATMENT DETAIL A





es are oriented without the length of the bearing. It is the responsibility of the the required length of any structural member on ella.

beared to be the responsibility of the offest unless the Architect is repeate agreement to undertake such matters. Short to wait for full planning permission and full building againstons to be

zi-za Donae i adowne	SITE ADDRESS:	PROPOSAL: CONVERSION OF THE EXISTING OFFICE AT THIRD FLOOR LEVEL TO STAFF ACCOMODATION		PROPOSAL:
REY:	DRAWN: $J.V$	DRAWING NUMBER: GLA-10L	SCALE:	DATE: 10.01.2019
	CHECK: R.K	GLA-1OL		